
GALVESTON, CHAMBERS & LIBERTY COUNTIES, TEXAS Tho TRINITY BAY PROPOSED 12" PIPELINE GALVESTON BAY CHAMBERS: GALVESTON BAY **GULF OF MEXICO** WS 1-30000 2195100_ Scale in Feet 15,000 30.000 30,000 15.000° BUCKEYE GULF COAST PIPE LINES, L.P. Permit Number 23290 HOUSTON, TEXAS **Buckeye Gulf Coast Pipelines** PROPOSED 12" PIPELINE February 23, 2004 ROUTE MAP GALVESTON, CHAMBERS & LIBERTY COUNTIES, TEXAS Page 1 of 35 DATE DATE: 12/03 MC. DRAWN BY: G&A HOUSTON, TEXAS 77012 31 SHEET 7705 S. LOOP E. CHECKED BY: G&A DATE: 12/03 (713) 644-8219 SCALE: 1"=30000 W.O. REV. O CAD FILE: 2195100_

LIBERTY, CHAMBERS & GALVESTON COUNTIES,

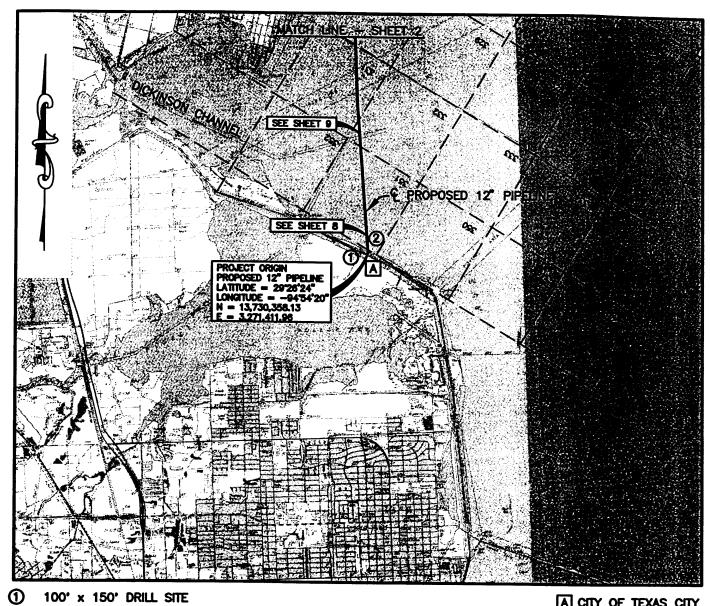

A CITY OF TEXAS CITY



Registered Professional Land Surveyor No. 4215

NOTE: ALL COORDINATES SHOWN ARE BASED ON THE TEXAS COORDINATE SYSTEM SOUTH CENTRAL ZONE. (NAD 83)

6000' 3000' 6000' 12000'

SCALE IN FEET

ADDITION ILE COE

150' x 200' DRILL

DATE

Permit Number 23290 **Buckeye Gulf Coast Pipelines** February 23, 2004 Page 2 of 35

BUCKEYE GULF COAST PIPE LINES, L.P.


HOUSTON, TEXAS


PROPOSED 12" PIPELINE MOSS BLUFF TO TEXAS CITY PLAN VIEW

GULLETT & ASSOCIATES. INC. 7705 S. LOOP E. HOUSTON, TEXAS 77012 (713) 644-3219


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LIBERTY, CHAMBERS & GALVESTON COUNTIES,

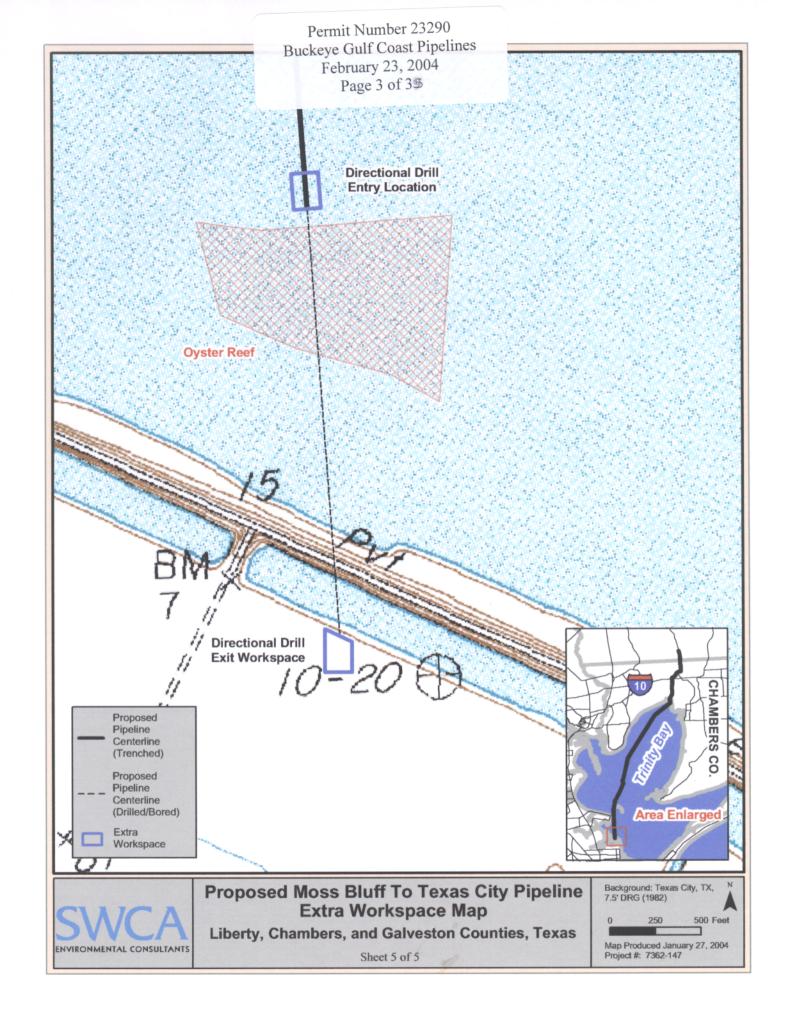

(3) 150' X 200' DRILL SITE (EACH SIDE OF HOUSTON SHIP CHANNEL)

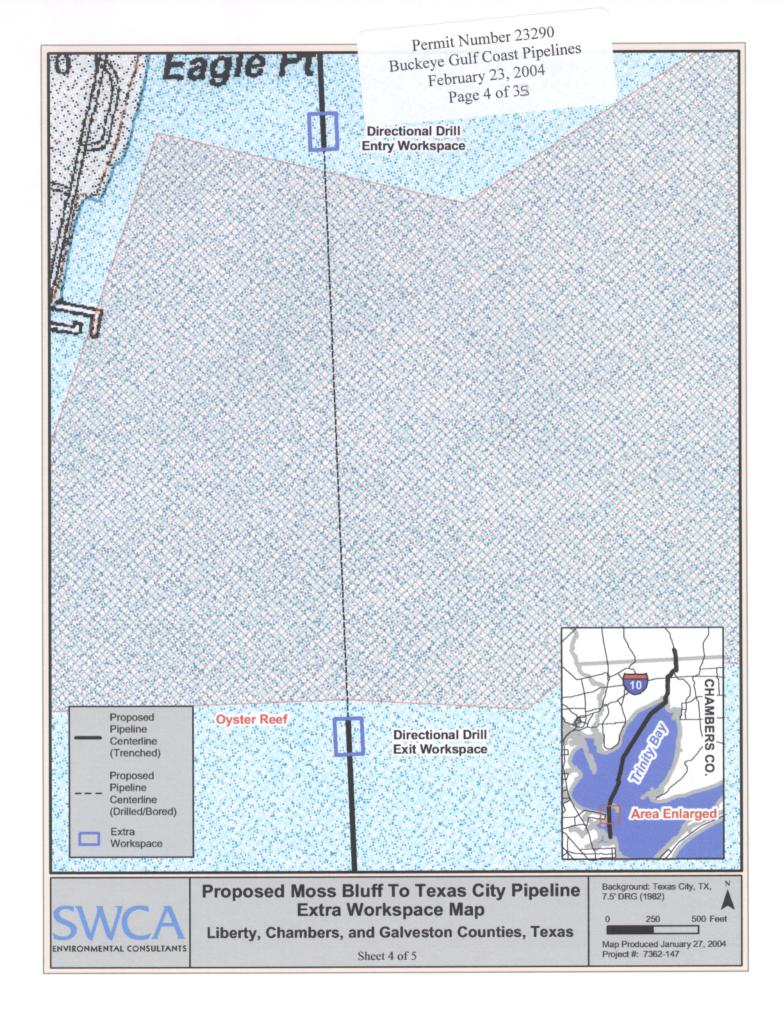

Fred P. Langham Registered Professional Land Surveyor No. 4215 NOTE: ALL COORDINATES SHOWN ARE BASED ON THE TEXAS COORDINATE SYSTEM SOUTH CENTRAL ZONE. (NAD 83)
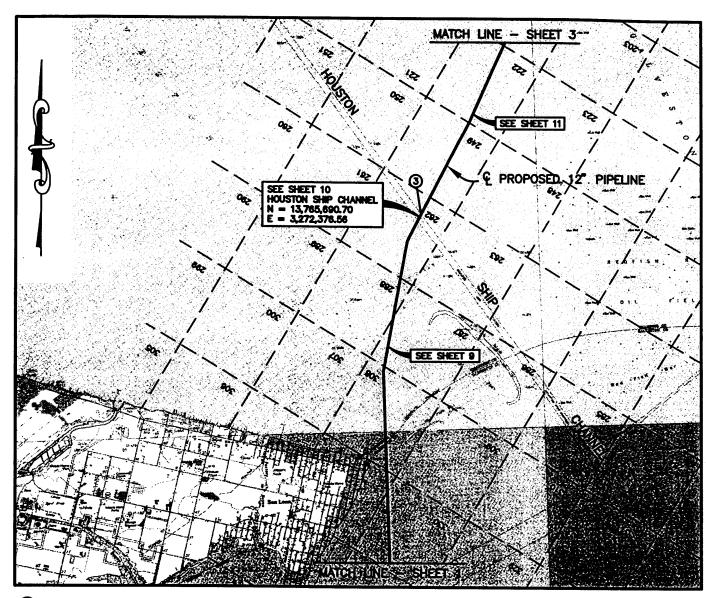
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SCALE IN FEET

APPLICATION: U.S. COE

Permit Number 23290 **Buckeye Gulf Coast Pipelines** February 23, 2004 Page 5 of 35

JUULALES, INC. COLLEGII HOUSTON, TEXAS 77012 7705 S. LOOP E. (713) 644-8219

BUCKEYE GULF COAST PIPE LINES, L.P.


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HOUSTON, TEXAS


PROPOSED 12" PIPELINE MOSS BLUFF TO TEXAS CITY PLAN VIEW

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SCALE: NOTED CAD FILE: 2195105_



LIBERTY, CHAMBERS & GALVESTON COUNTIES, **TEXAS**

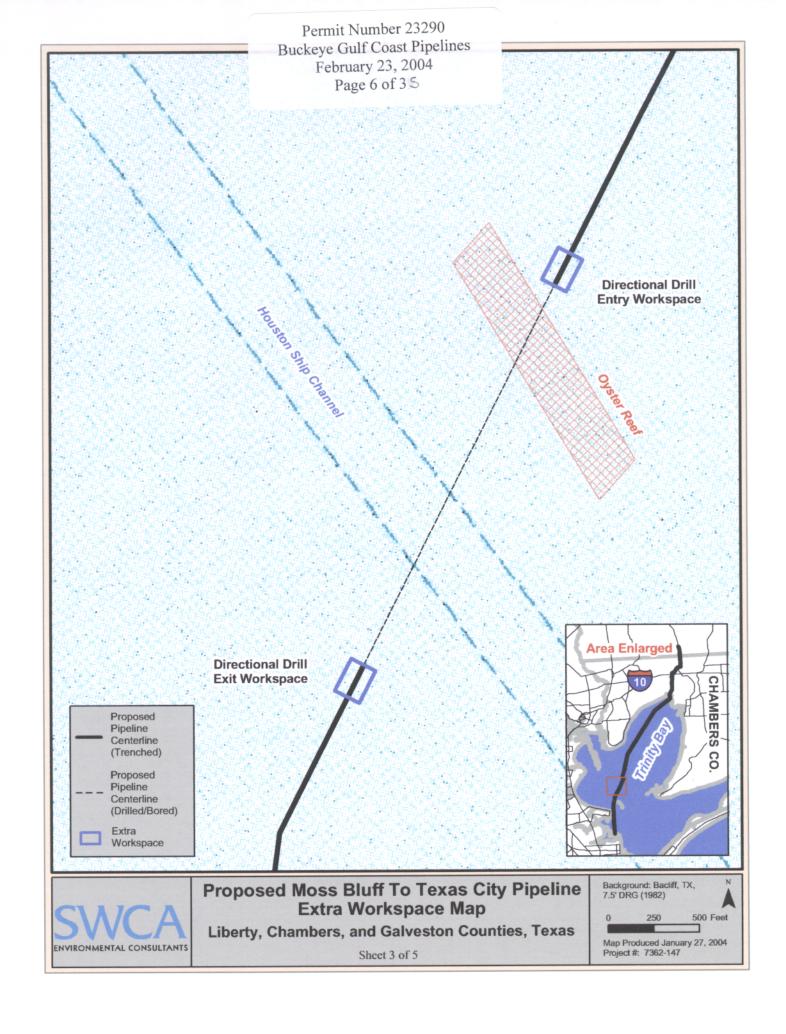

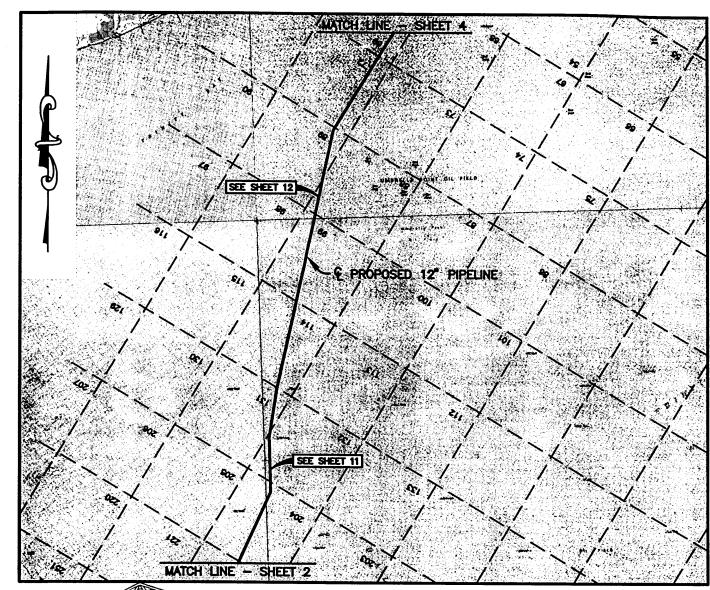

Fred P. Langham Registered Professional Land Surveyor No. 4215

NOTE: ALL COORDINATES SHOWN ARE BASED ON THE TEXAS COORDINATE SYSTEM SOUTH CENTRAL ZONE. (NAD 83)

6000' 3000'

6000

12000'

SCALE IN FEET

Permit Number 23290 **Buckeye Gulf Coast Pipelines** February 23, 2004 Page 7 of 35

BUCKEYE GULF COAST PIPE LINES, L.P.

HOUSTON, TEXAS

PROPOSED 12" PIPELINE MOSS BLUFF TO TEXAS CITY PLAN VIEW

GULLETT & ASSOCIATES, INC. 7705 S. LOOP E. HOUSTON, TEXAS 77012 (718) 644-8219


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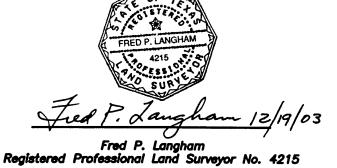
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LIBERTY, CHAMBERS & GALVESTON COUNTIES, **TEXAS**





NOTE: ALL COORDINATES SHOWN ARE BASED ON THE TEXAS COORDINATE SYSTEM SOUTH CENTRAL ZONE. (NAD 83)

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SCALE IN FEET

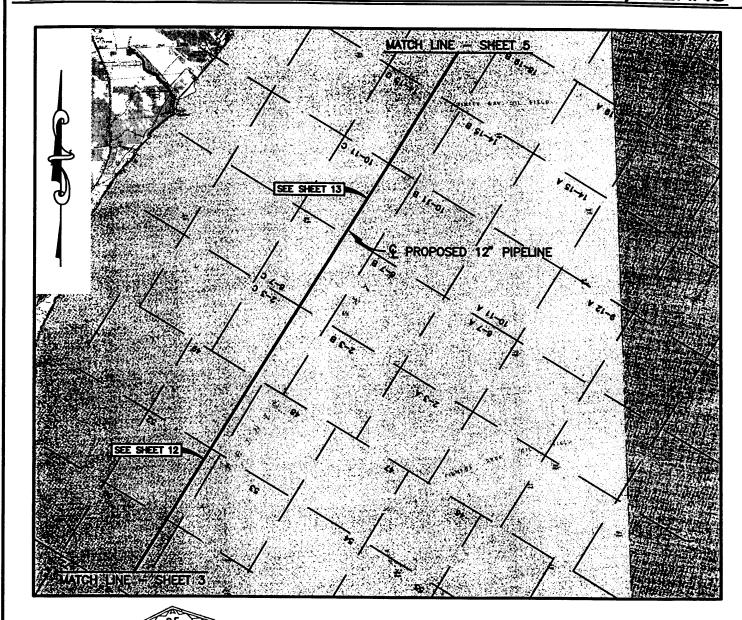Permit Number 23290 **Buckeye Gulf Coast Pipelines** February 23, 2004 Page 8 of 35

BUCKEYE GULF COAST PIPE LINES, L.P.

HOUSTON, TEXAS

PROPOSED 12" PIPELINE MOSS BLUFF TO TEXAS CITY PLAN VIEW


GULLETT & ASSOCIATES, INC. 7705 S. LOOP E. HOUSTON, TEXAS 77012 (718) 644-8219

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NO. DATE

LIBERTY, CHAMBERS & GALVESTON COUNTIES, TEXAS



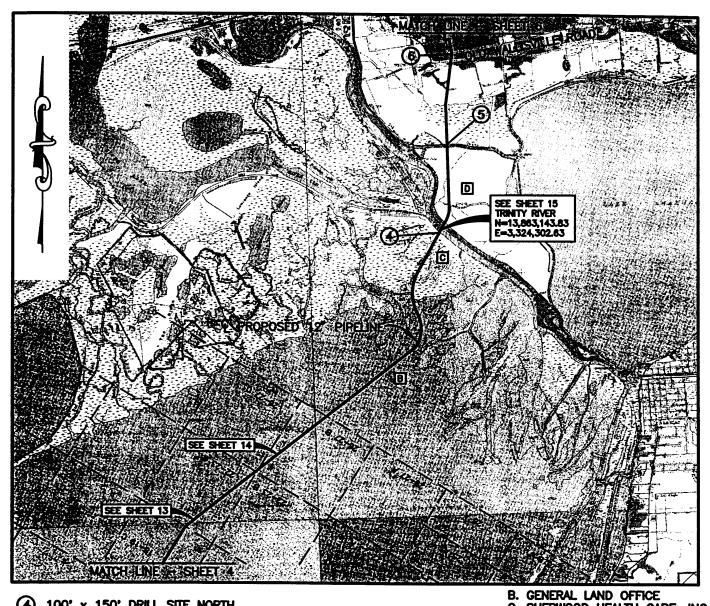

100' x 150' DRILL SITE NORTH

& SOUTH BANK HOG BAYOU (6) 150' x 200' LAND PLISE

Fred P. Registered Professional Land Surveyor No. 4215 C. SHERWOOD HEALTH CARE, INC. D. JOHN G. MIDDLETON, et al

NOTE: ALL COORDINATES SHOWN ARE BASED ON THE TEXAS COORDINATE SYSTEM SOUTH CENTRAL ZONE. (NAD 83) (NAD 83)

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SCALE IN FEET

Permit Number 23290 **Buckeye Gulf Coast Pipelines** February 23, 2004 Page 9 of 35

BUCKEYE GULF COAST PIPE LINES, L.P.

HOUSTON, TEXAS

PROPOSED 12" PIPELINE MOSS BLUFF TO TEXAS CITY PLAN VIEW

GULLETT & ASSOCIATES, INC. 7705 S. LOOP E. HOUSTON, TEXAS 77012

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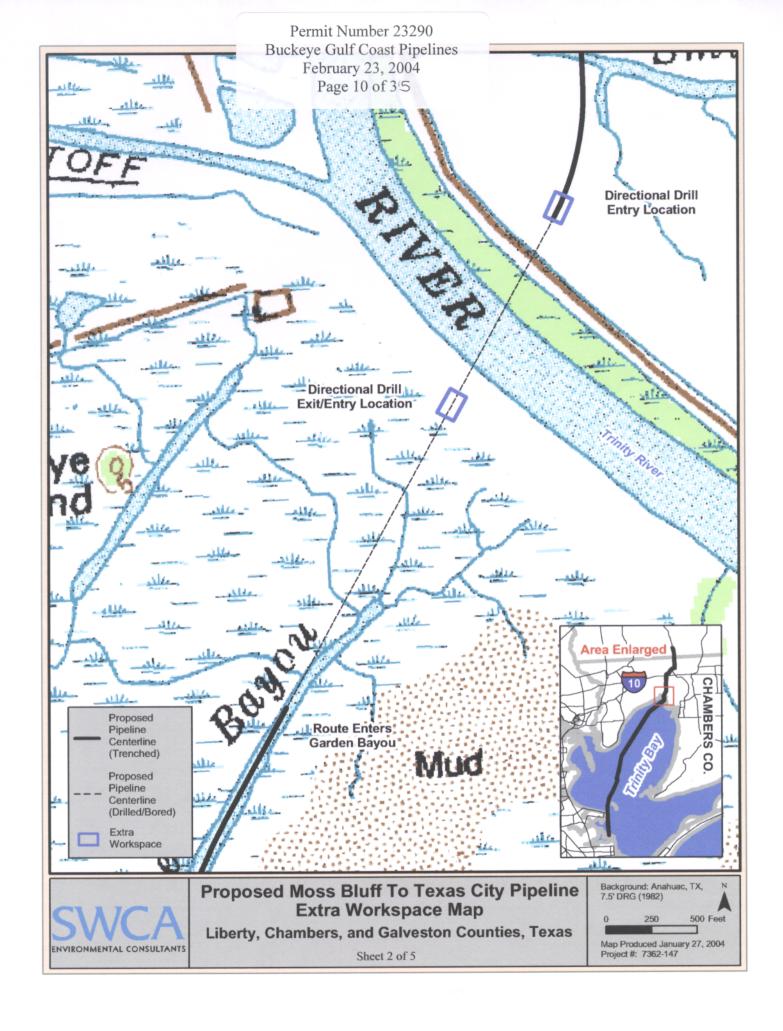
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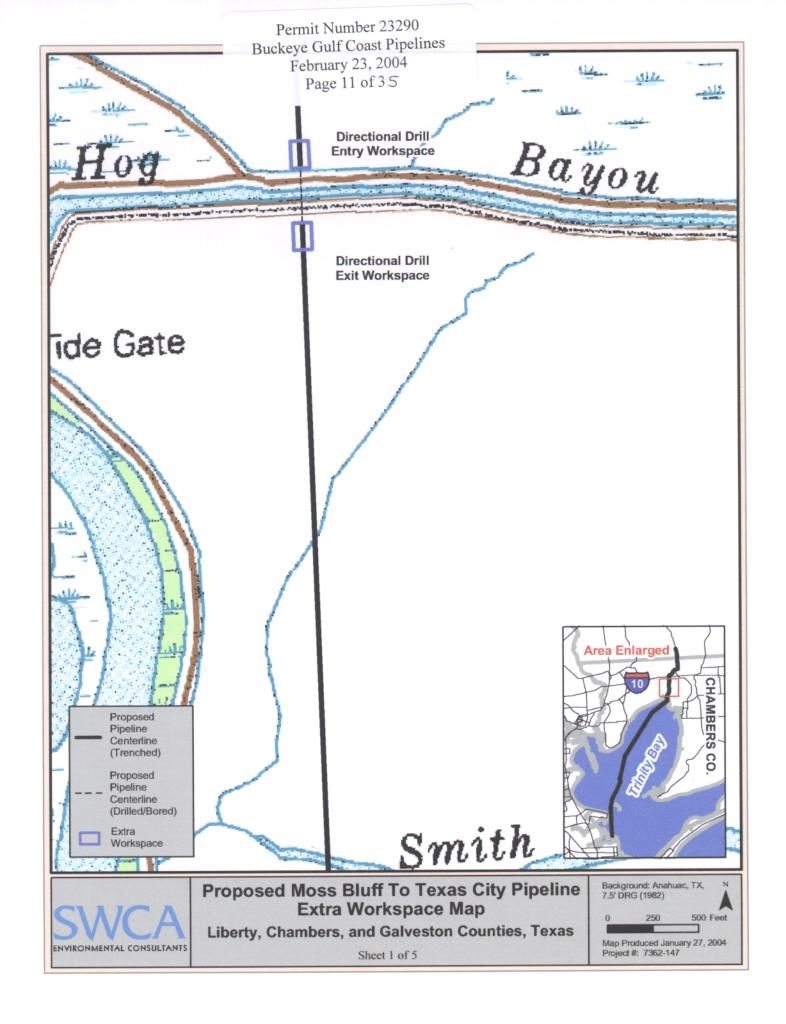
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SCALE: NOTED


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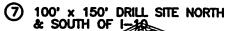
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LIBERTY, CHAMBERS & GALVESTON COUNTIES, TEXAS







Fred P. Langham
Registered Professional Land Surveyor No. 4215

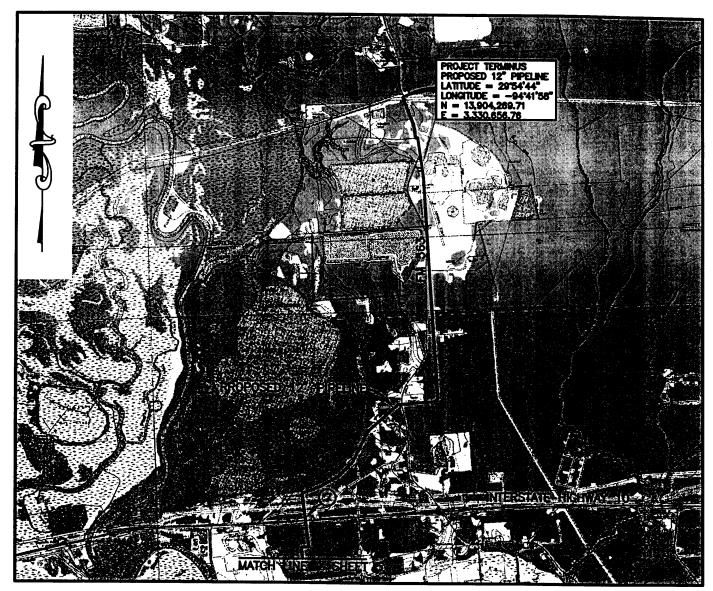NOTE: ALL COORDINATES SHOWN ARE BASED ON THE TEXAS COORDINATE SYSTEM SOUTH CENTRAL ZONE. (NAD 83)

6000' 3000' 0' 6000' 12000'

SCALE IN FEET

Permit Number 23290 Buckeye Gulf Coast Pipelines February 23, 2004 Page 12 of 35

BUCKEYE GULF COAST PIPE LINES, L.P.

HOUSTON, TEXAS

PROPOSED 12" PIPELINE MOSS BLUFF TO TEXAS CITY PLAN VIEW

GULLETT & ASSOCIATES, INC. 7705 8. LOOP E. HOUSTON, TEXAS 77012 (713) 644-3219


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SHEET 7 OF 31


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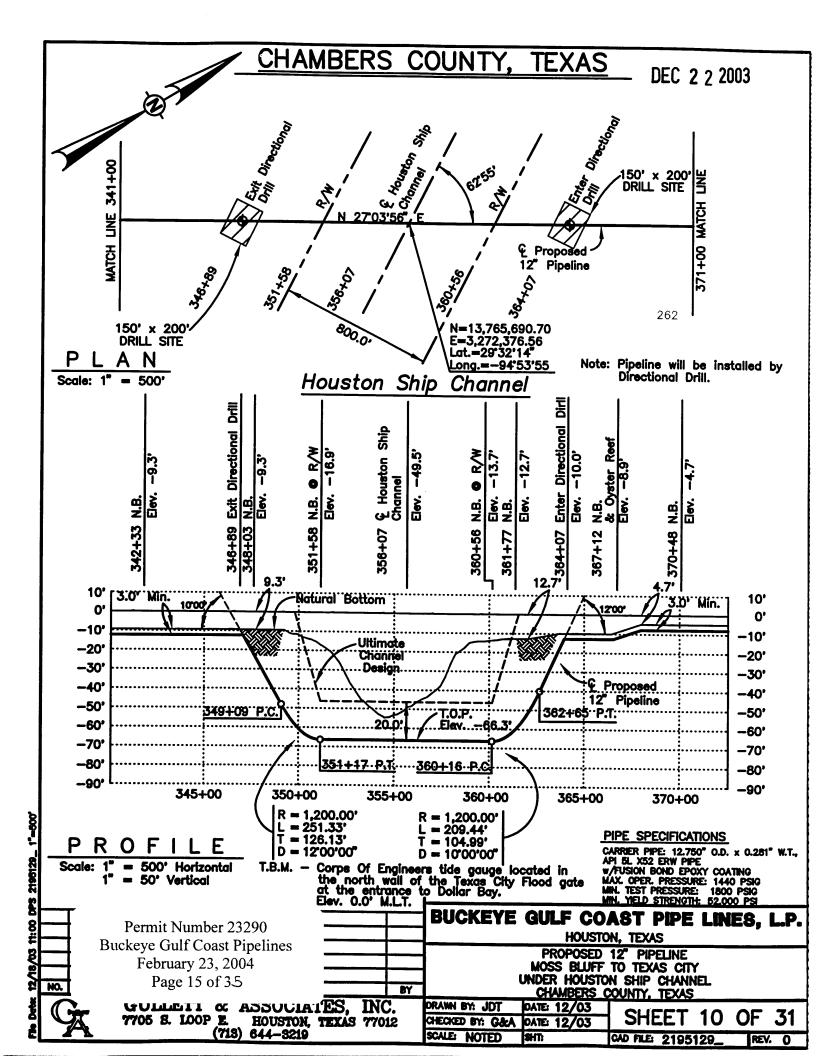
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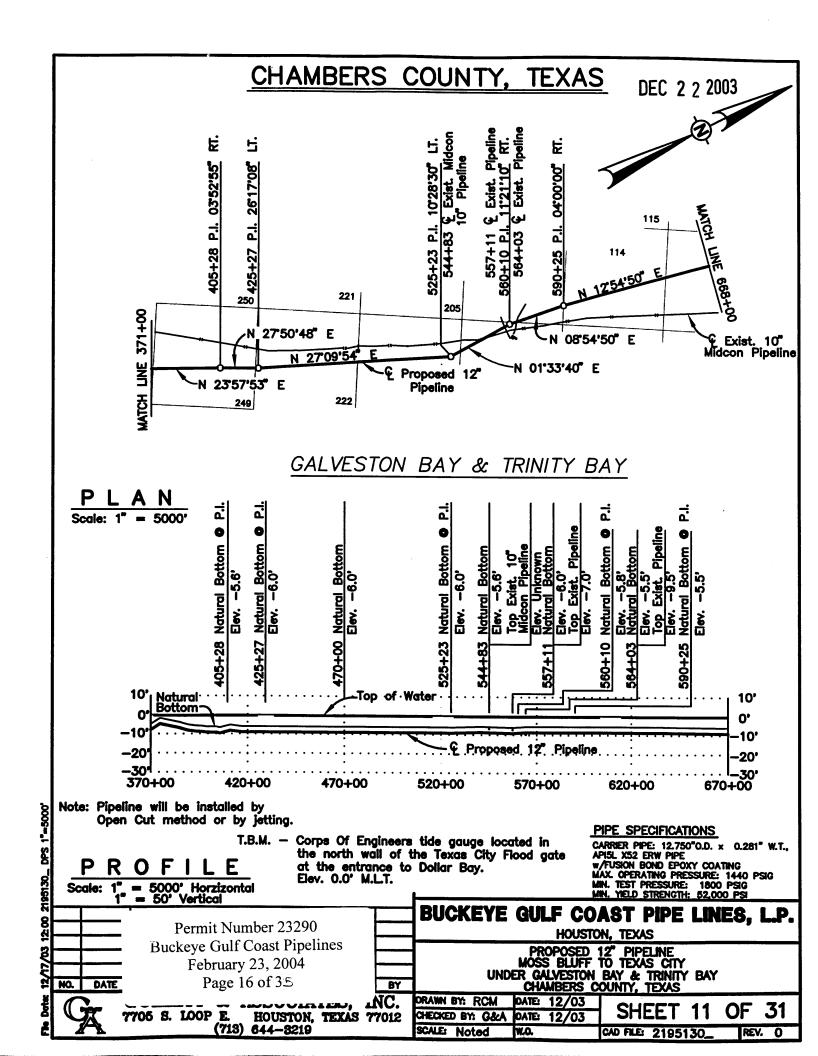
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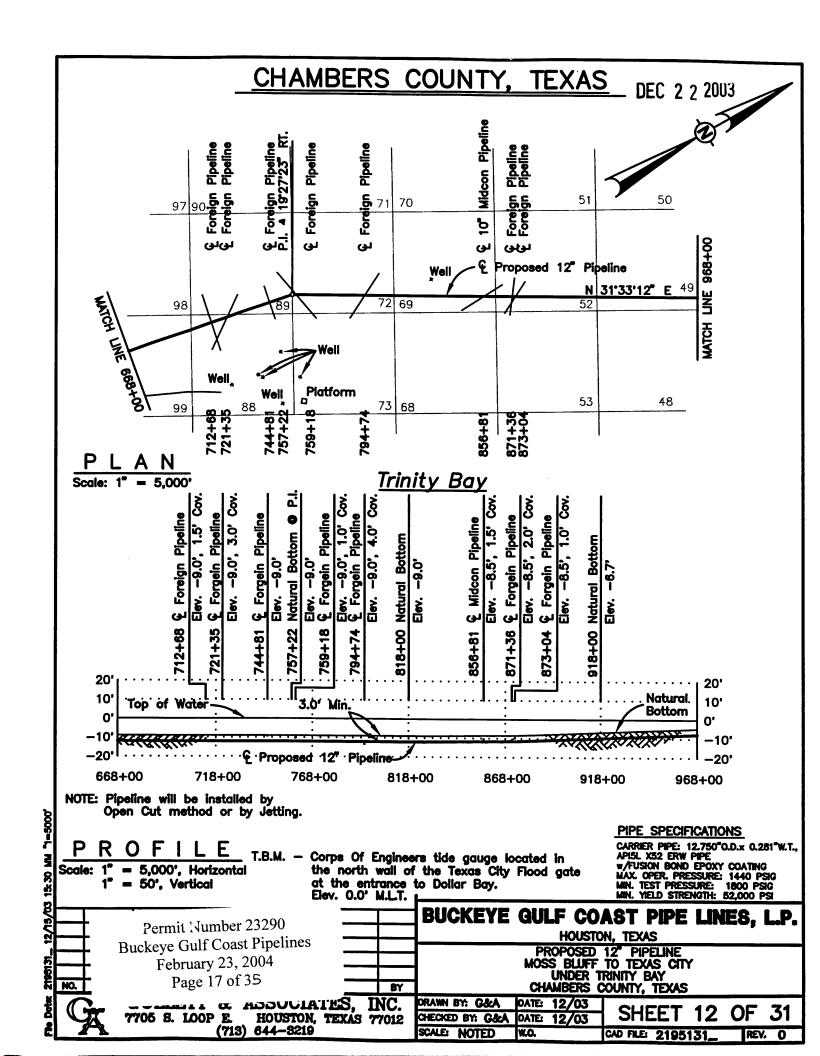



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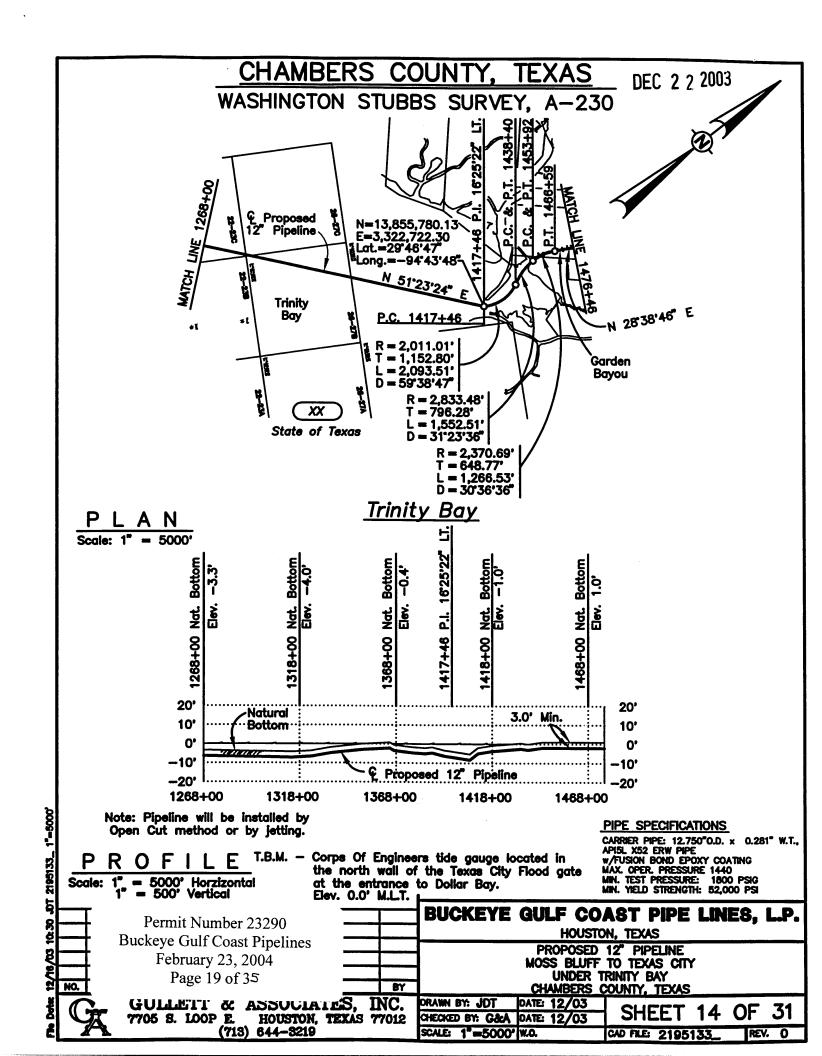








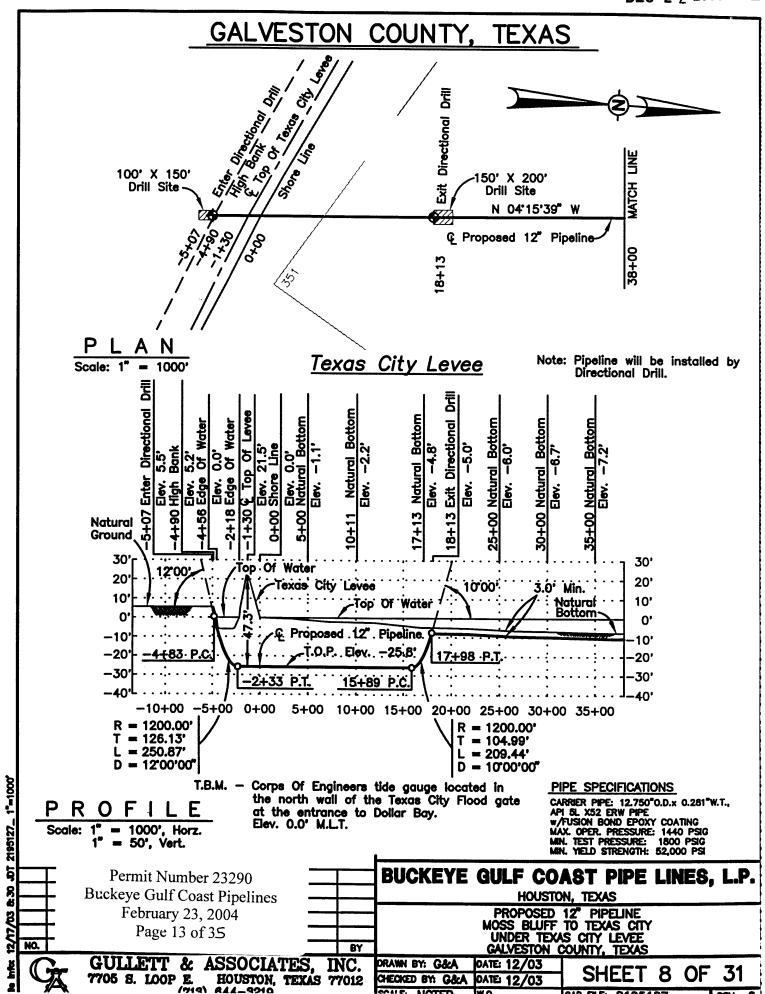


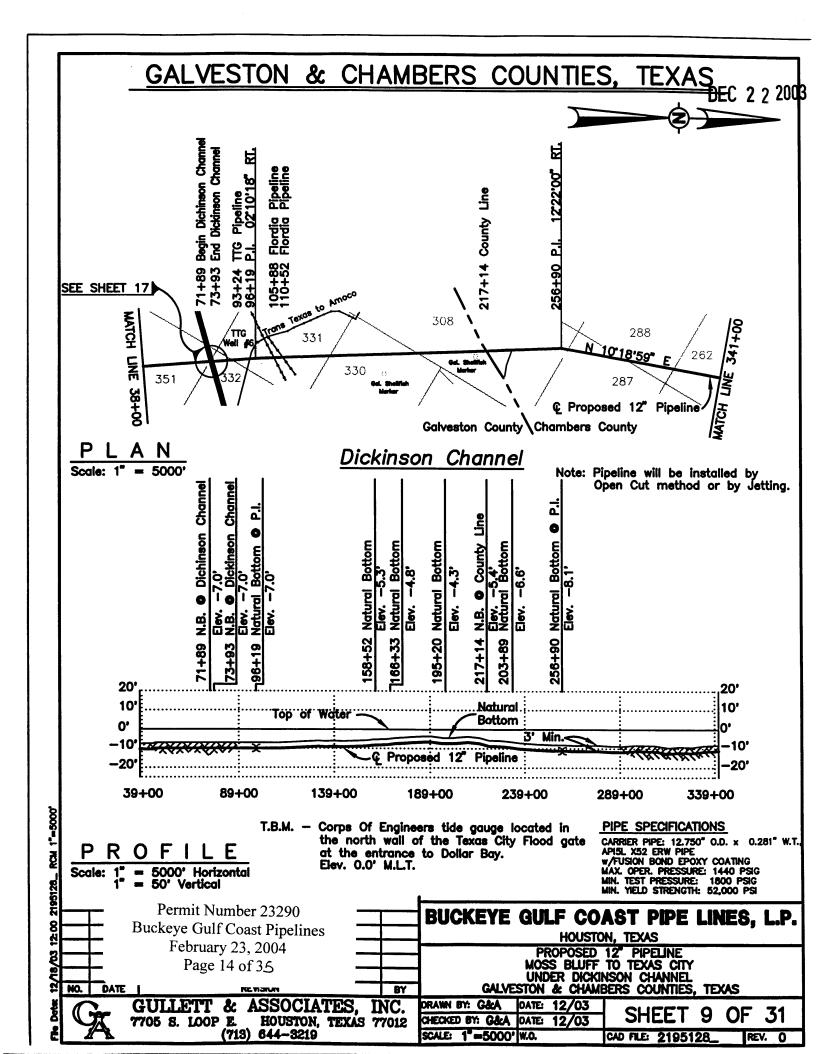


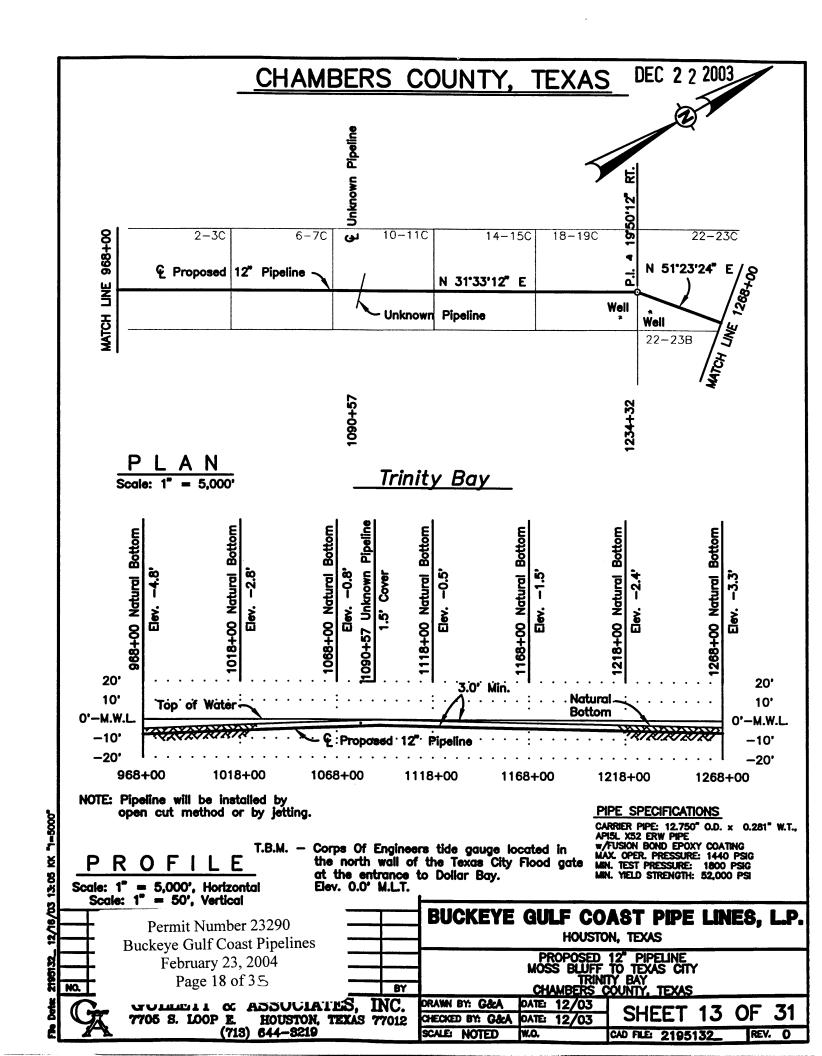


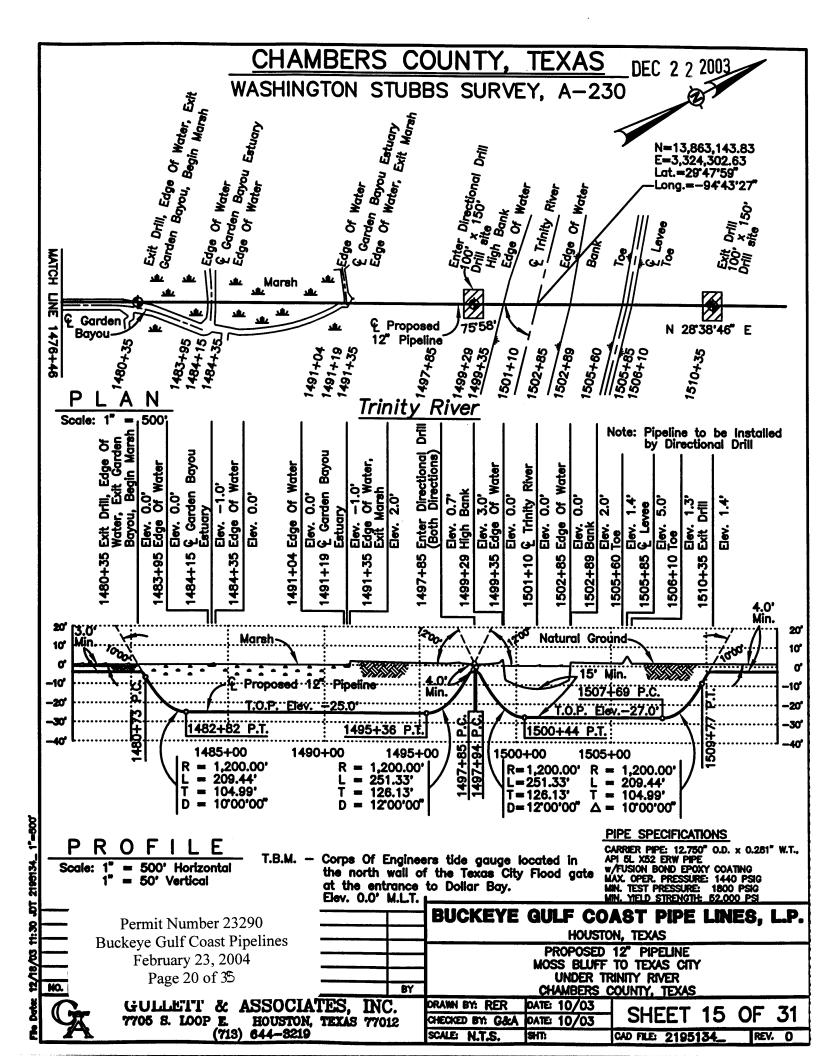


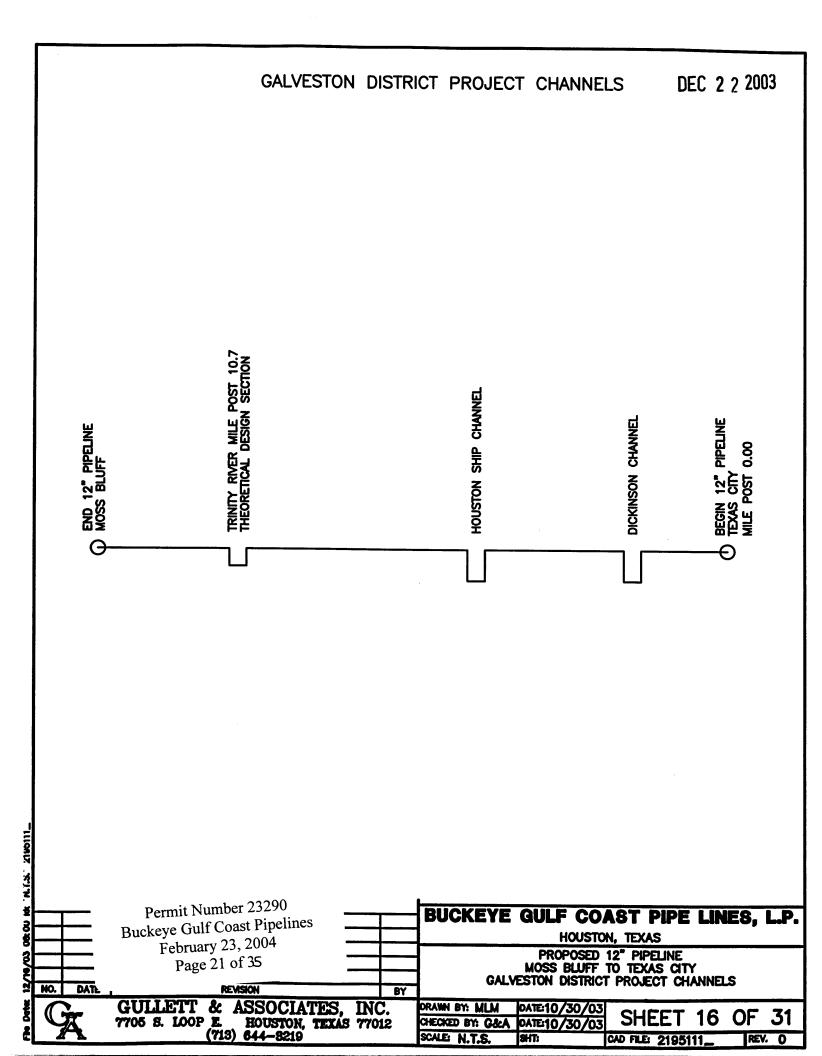


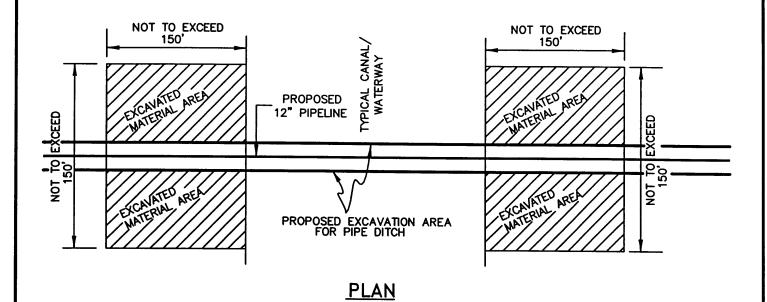


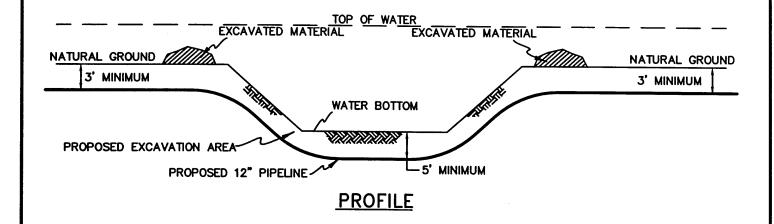

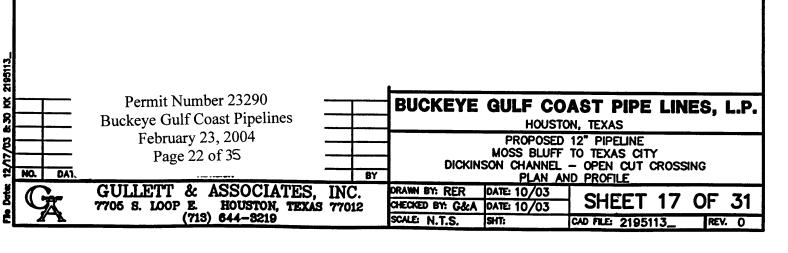


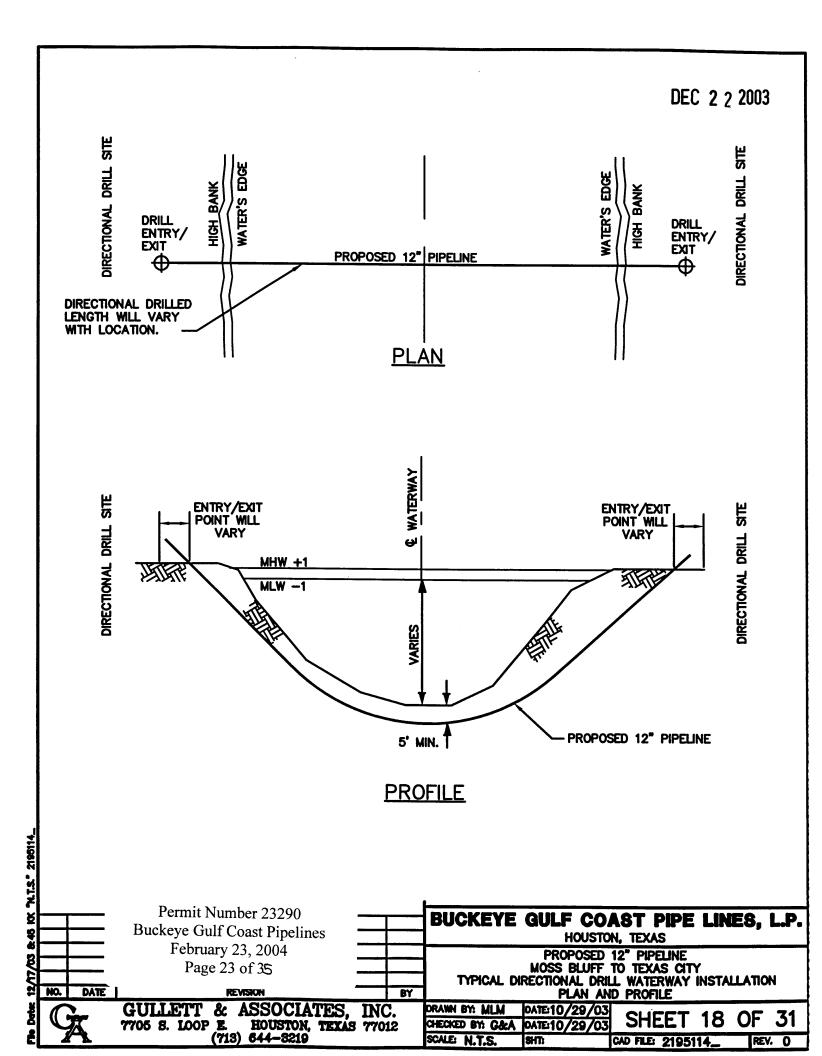


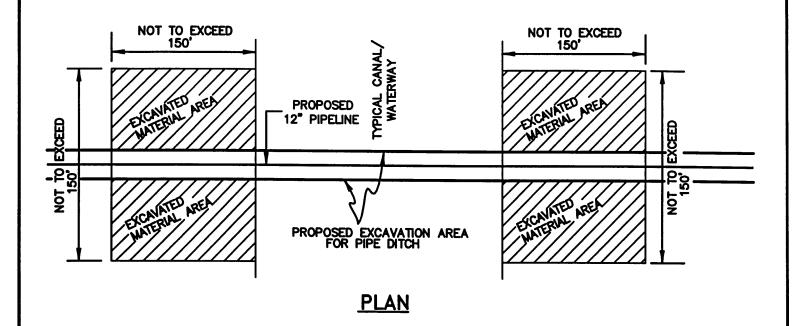

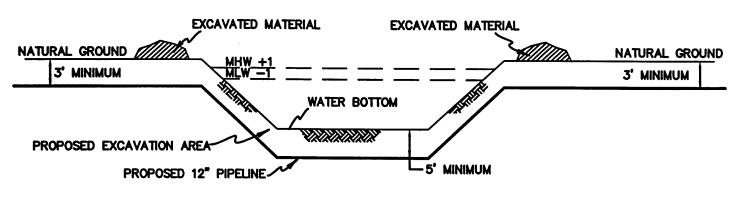

PROFILE

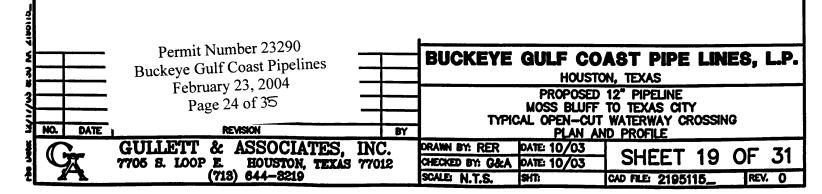

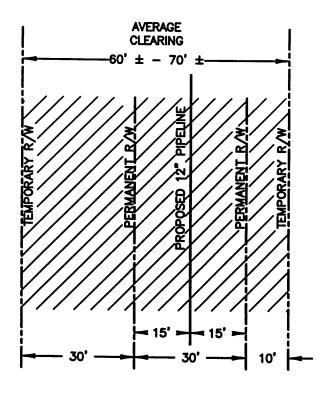

PLAN N.T.S.



INDICATES CLEARING

Permit Number 23290 Buckeye Gulf Coast Pipelines February 23, 2004 Page 25 of 35

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NO.

DATE

BUCKEYE GULF COAST PIPE LINES, L.P.


HOUSTON, TEXAS

PROPOSED 12" PIPELINE
MOSS BLUFF TO TEXAS CITY
TYPICAL RIGHT-OF-WAY, FORESTED WETLAND
LIBERTY & CHAMBERS COUNTY, TEXAS

GULLETT & ASSOCIATES, INC. 7705 S. LOOP E. HOUSTON, TEXAS 77012 (718) 644-8219

CHECKED BY: MLM OATE:10/29/03 SHEE:
SCALE: N.T.S. SHT: CAD FILE: 215

SHEET 20 OF 31

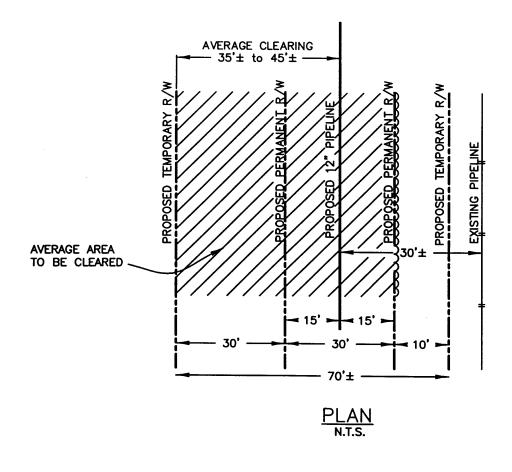



Permit Number 23290 **Buckeye Gulf Coast Pipelines** February 23, 2004 Page 26 of 35

REVISION

BUCKEYE GULF COAST PIPE LINES, L.P. HOUSTON, TEXAS

PROPOSED 12" PIPELINE
MOSS BLUFF TO TEXAS CITY
TYPICAL R/W, FORESTED WETLAND-PARALLEL PIPELINE
LIBERTY & CHAMBERS COUNTY, TEXAS


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DATE

BY ASSOCIATES, GULLETT & 7705 S. LOOP E. HOUSTON, TEXAS 77012 (713) 644-3219

12/15/03



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Permit Number 23290 **Buckeye Gulf Coast Pipelines** February 23, 2004 Page 27 of 35

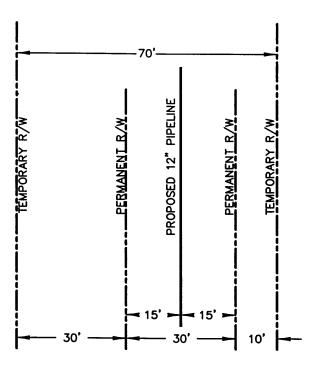BUCKEYE GULF COAST PIPE LINES, L.P.

HOUSTON, TEXAS

PROPOSED 12" PIPELINE
MOSS BLUFF TO TEXAS CITY
TYPICAL RIGHT-OF-WAY, NONFORESTED WETLAND
LIBERTY & CHAMBERS COUNTY, TEXAS

OF


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GULLETT & 7705 S. LOOP E. & ASSOCIATES, INC. E. HOUSTON, TEXAS 77012 (713) 644-8219

DATE: 12/16/03 DRAWN BY: RCM CHECKED BY: G&A DATE: 12/16/03 SCALE: N.T.S. SHT: CAD FILE: 2195112

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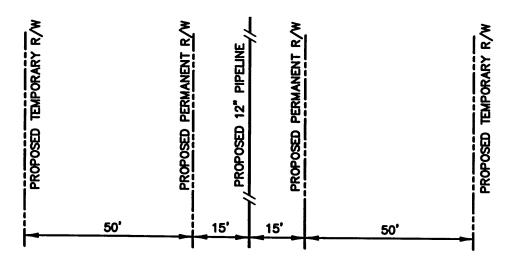
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NOTE: APPLIES TO NONFORESTED WETLAND (MARSH) SOUTH OF LAND PUSH SITE. SHOWN ON SHEET 6 OF 31.

GALVESTON DISTRICT Permit Number 23290 BUCKEYE GULF COAST PIPE LINES, L.P. **Buckeye Gulf Coast Pipelines** HOUSTON, TEXAS February 23, 2004 PROPOSED 12" PIPELINE
MOSS BLUFF TO TEXAS CITY
TYPICAL RIGHT-OF-WAY OF MARSH
CHAMBERS COUNTY, TEXAS Page 28 of 3'5 BY GULLETT **ASSOCIATES** DATE:12/16/03 DRAWN BY: RCM OF 31 7705 S. LOOP E. HOUSTON, TEXAS 77012 CHECKED BY: G&A OATE:12/16/03 (713) 644-8219 SCALE: N.T.S. SHT: CAD FILE: 2195118_ REV.

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Permit Number 23290 **Buckeye Gulf Coast Pipelines** February 23, 2004 Page 29 of 3S
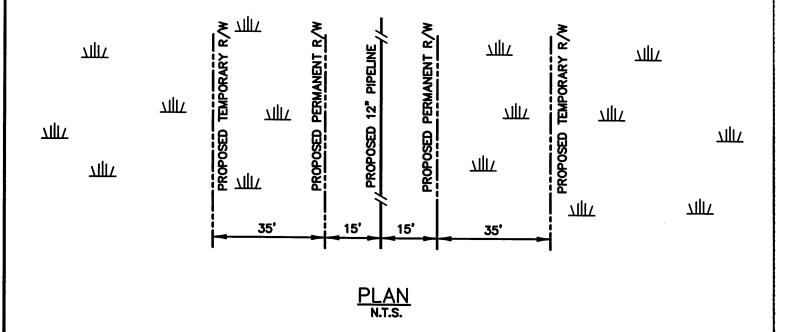
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DATE

NO.

GALVESTON DISTRICT BUCKEYE GULF COAST PIPE LINES, L.P.

HOUSTON, TEXAS

PROPOSED 12" PIPELINE
MOSS BLUFF TO TEXAS CITY
TYPICAL RIGHT-OF-WAY OF BAY
CHAMBERS COUNTY, TEXAS


BY & ASSOCIATES, INC. E. HOUSTON, TEXAS 77012 (713) 644-3219 GULLETT & 7705 S. LOOP E GULLETT


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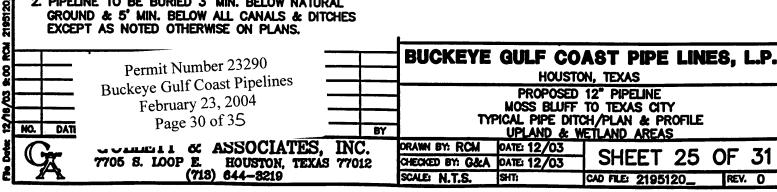
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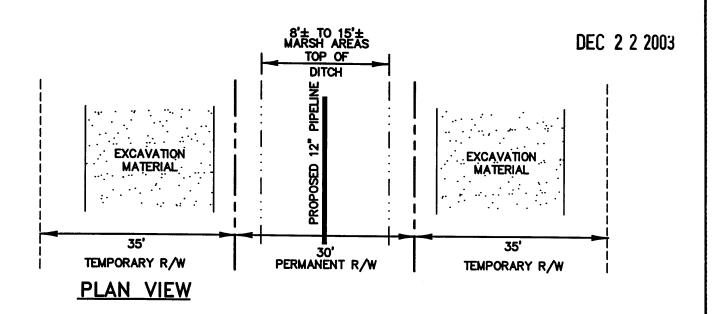





NOTE:

- 1. EXCAVATED MATERIAL TO BE STOCKPILED ON JOB SITE ADJACENT TO PIPE DITCH. AVAILABLE MATERIAL TO BE USED AS BACKFILL FOLLOWING PIPELINE INSTALLATION.
- 2. PIPELINE TO BE BURIED 3' MIN. BELOW NATURAL GROUND & 5' MIN. BELOW ALL CANALS & DITCHES EXCEPT AS NOTED OTHERWISE ON PLANS.

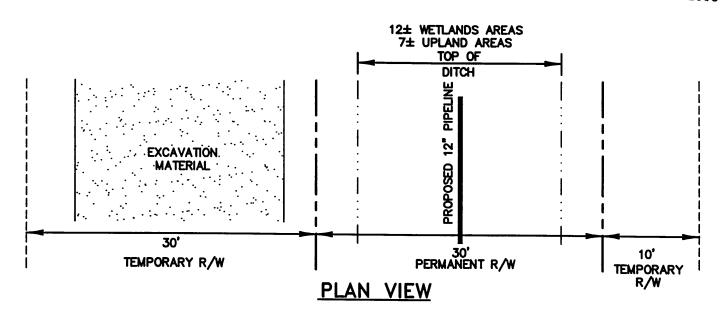

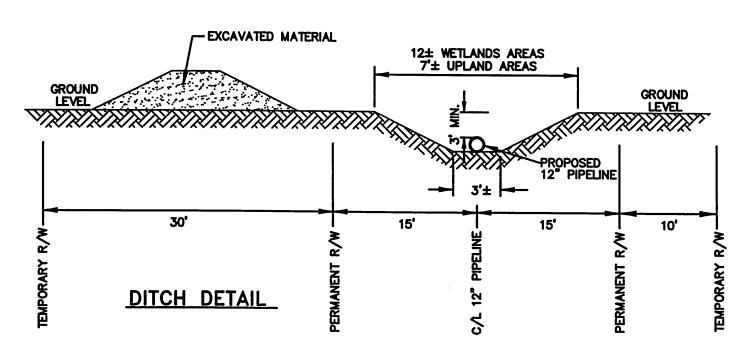

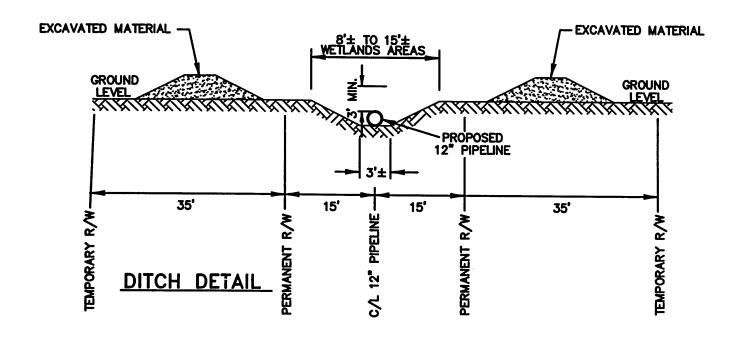

NOTE:

1. EXCAVATED MATERIAL TO BE STOCKPILED ON JOB SITE ADJACENT TO PIPE DITCH. AVAILABLE MATERIAL TO BE USED AS BACKFILL FOLLOWING PIPELINE INSTALLATION.

2. PIPELINE TO BE BURIED 3' MIN. BELOW NATURAL GROUND & 5' MIN. BELOW ALL CANALS & DITCHES EXCEPT AS NOTED OTHERWISE ON PLANS.

NOTE: APPLIES TO NONFORESTED WETLAND (MARSH) SOUTH OF LAND PUSH SITE. SHOWN ON SHEET 6 OF 31

Permit Number 23290
Buckeye Gulf Coast Pipelines
February 23, 2004
Page 31 of 35

BUCKEYE GULF COAST PIPE LINES, L.P.


HOUSTON, TEXAS

PROPOSED 12" PIPELINE
MOSS BLUFF TO TEXAS CITY
TYPICAL PIPE DITCH/PLAN & PROFILE
MARSH AREA


GULLETT & ASSOCIATES, INC. 7705 S. LOOP E. HOUSTON, TEXAS 77012 (713) 644-8219 ORAWN BY: RCM OATE: 12/03
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Permit Number 23290 **Buckeye Gulf Coast Pipelines** February 23, 2004 Page 33 of 35

BUCKEYE GULF COAST PIPE LINES, L.P.

HOUSTON, TEXAS

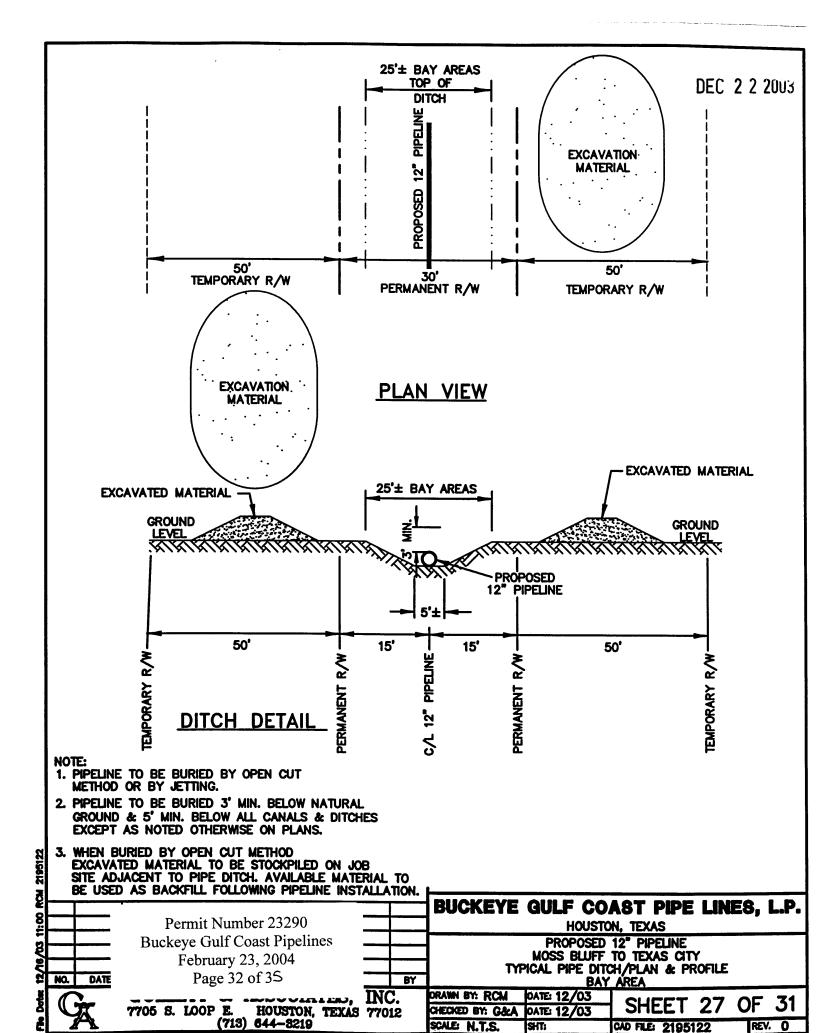
PROPOSED 12" PIPELINE MOSS BLUFF TO TEXAS CITY TYPICAL BARGE PUSH SITE DETAIL

DATE GULLETT & ASSOCIATES, INC. 7705 S. LOOP E. HOUSTON, TEXAS 77012 (713) 644-3219

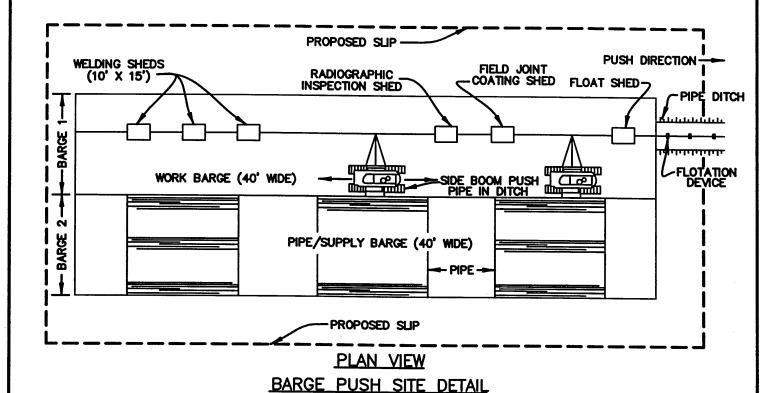
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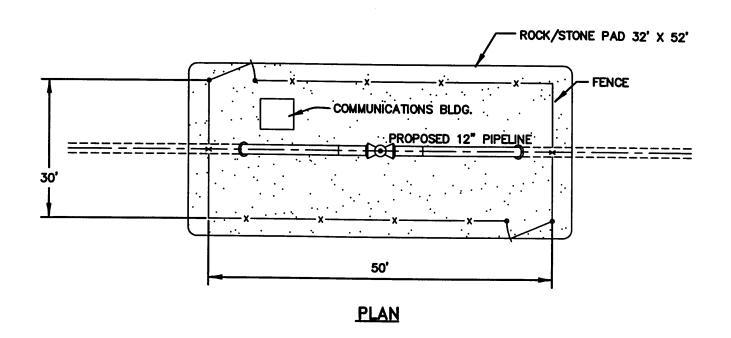
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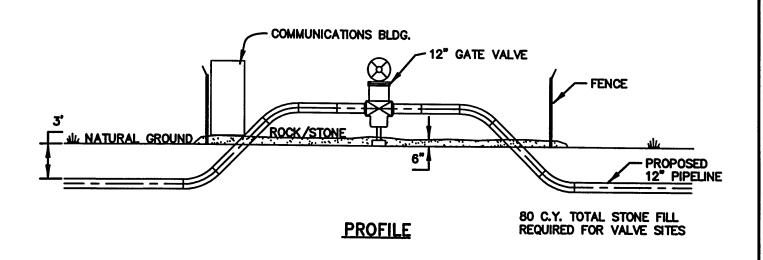



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BUCKEYE GULF COAST PIPE LINES, L.P. MOSS BLUFF TO TEXAS CITY HYDROGEN PIPELINE PROJECT LIBERTY, CHAMBERS, AND GALVESTON COUNTIES, TEXAS

MITIGATION, RESTORATION, AND MONITORING PLAN

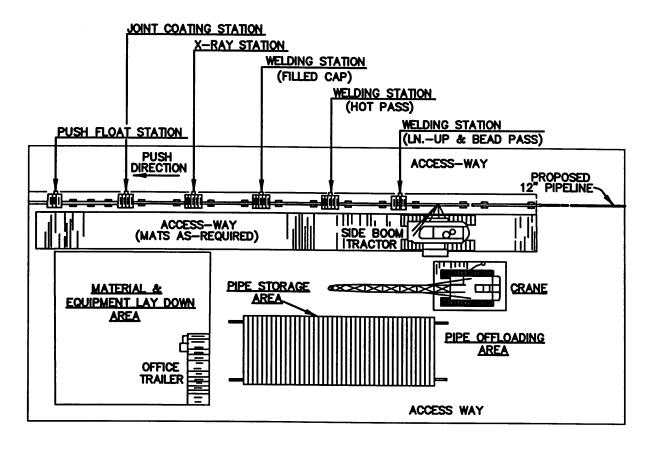January 20, 2004

The following document contains information relative to wetland mitigation, restoration, and monitoring for Individual Permit Application 23290 submitted to the U.S. Army Corps of Engineers (USACE).

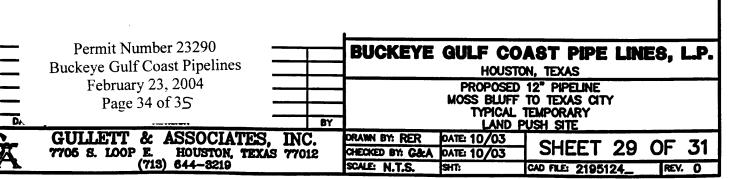BACKGROUND

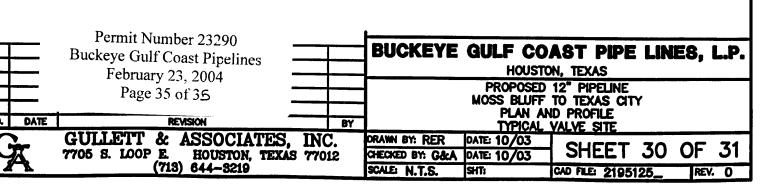Buckeye Gulf Coast Pipe Lines, L.P. (Buckeye) is proposing the construction of approximately 38 miles of a 12-inch diameter pipeline, known as the 12" Moss Bluff to Texas City Hydrogen Pipeline. The proposed route begins in the Moss Bluff area in Liberty County north of Interstate Highway 10 (I-10) and east of Wallisville Reservoir. The route proceeds south then southwest, crossing Trinity and Galveston Bays. The route ends west of Dollar Point in Texas City, Texas. Buckeye proposes to begin construction on June 1, 2004.

North of Old Wallisville Road, the pipeline primarily parallels existing pipeline corridors, crossing through a variety of forested and non-forested upland and wetland habitats. South of Old Wallisville Road, the route crosses a narrow band of upland forest before descending into a variety of wetland habitats, including forested, scrub-shrub, and palustrine emergent (PEM) fresh marsh.

Wetland habitats between Old Wallisville Road and the Trinity River are completely enclosed within a levee system that begins at Wallisville Reservoir and wraps around land all the way to the north end of Lake Anahuac. Hydrology is provided from sheet flow into the marsh from the north. Hydrology is controlled via pumps that pump water over the levee and out of the marsh into the Trinity River and Lake Anahuac. Much of the wetland habitat south of Old Wallisville Road has been historically used for rice production. Today, the area south of Old Wallisville Road, including the PEM fresh marsh, belongs to private landowners and is used for cattle grazing.

South of the Trinity River, the preferred route avoids and minimizes salt marsh impacts by directional drill before crossing into Trinity Bay. The route crosses approximately 28 miles of Trinity and Galveston Bays before coming ashore in upland pasture inside the Texas City Levee west of Dollar Point. Please refer to SWCA's preliminary wetland delineation for a discussion of all temporary and permanent wetland impacts associated with this project.

Permit Number 23290
Buckeye Gulf Coast Pipelines
February 23, 2004
Attachment 1
Page 1 of 4

MITIGATION

The USACE preferred sequencing of wetland impact avoidance, minimization, and finally compensatory mitigation has been followed throughout project development. Please refer to SWCA's Alternatives Analysis for a detailed description of impact avoidance and minimization through the route selection process. Buckeye has chosen a preferred route that avoids and minimizes wetland impacts to the maximum extent practicable. In addition, Buckeye has reduced typical ROW widths in wetland areas as much as possible.

Temporary impacts to non-forested wetlands will be mitigated on-site during and post-construction by ROW restoration and monitoring as detailed below. On-site mitigation for permanent impacts (i.e. forested wetlands) is not logistically feasible. Buckeye does not hold title to the project ROW. In addition, no practicable mitigation alternatives have been identified near the proposed project. Therefore, off-site mitigation in the same watershed is proposed for unavoidable permanent project impacts.

Temporary Impacts

Temporarily impacted areas are those necessary to have sufficient workspace to construct the pipeline. All impacts to non-forested wetland areas will be temporary. Please refer to SWCA's Wetland Delineation for acreages and locations of temporary wetland impacts.

Best Management Practices (BMPs) to minimize temporary impacts during construction will include:

- The use of low-ground weight equipment in wetland areas during pipeline construction.
- Limited passes through wetland areas will be employed and construction equipment in wetland areas will be limited to that needed to install the pipeline and restore the ROW.
- Excavated materials will be placed in such a manner as to not significantly alter drainage.
- Soil erosion controls such as silt fencing will be utilized, as necessary, to prevent sedimentation of adjacent habitat.
- Buckeye proposes to construct the pipeline primarily utilizing conventional pipeline construction methods. However, Buckeye proposes to minimize impacts in the emergent fresh marsh south of Old Wallisville Road by employing the "push" method. This method helps minimize traffic up and down the pipeline construction corridor and associated wetland impacts. The "push" method of construction will consist of trench excavation and sidecast of excavated material using a wide-tracked backhoe, marsh backhoe or marsh dragline. After the desired length of trench has been excavated, adjacent water and groundwater fill the trench. Individual pipe joints will be welded at a temporary extra workspace area at the north end of the marsh, and as each joint is successfully welded, the pipeline will be floated or "pushed" down the trench. Once the pipeline has been

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floated to both ends, it is sunk in place. The trench is then refilled using the adjacent excavated material.

- In the emergent fresh water marsh south of Old Wallisville Road, the top 12 to 16 inches of soil will be segregated during temporary sidecasting and replaced in the top portion of the backfilled trench. This will help reestablishment of wetland vegetation following pipeline installation.
- The Trinity River, Big Hog Bayou, and Houston Ship Channel, as well as pipeline transitions from onshore to offshore areas, will be installed via directional drill which will avoid and minimize impacts to waters of the U.S., including wetlands.

Permanent Impacts

Permanently impacted areas include those wetland areas which are currently forested, but that will be cleared during construction and/or maintained in an herbaceous state throughout existence of the pipeline for inspection and safety reasons. Buckeye has avoided and minimized impacts to forested wetland areas to the maximum extent practicable. Please refer to SWCA's Wetland Delineation for acreages and locations of forested wetland impacts.

Compensatory mitigation is proposed for unavoidable impacts to forested wetlands. Buckeye proposes to conduct compensatory mitigation in accordance with the USACE Galveston District In-Lieu Fee Mitigation program with an approved In-Lieu-Fee Operator.

Buckeye proposes to enter into an In-Lieu Fee mitigation agreement with the National Fish and Wildlife Foundation. Buckeye anticipates making a contribution to the National Fish and Wildlife Foundation's Lower Trinity River Habitat Fund. This contribution would then be used to acquire, preserve, enhance and/or restore wetland habitat in the Lower Trinity River watershed. This will provide mitigation in the same watershed as the proposed project's unavoidable wetland impacts.

Neither a mitigation ratio, nor a contribution amount, has been proposed for this project at the time of this writing. Buckeye proposes to discuss mitigation costs with National Fish and Wildlife Foundation upon initial agency concurrence. A complete mitigation plan with monitoring parameters will be provided to the USACE by the In-Lieu-Fee Operator. The In-Lieu-Fee Operator will assume all responsibility for restoration, monitoring, and success of mitigation for impacts to forested wetlands.

RESTORATION

The grade of the entire ROW will be restored to pre-project contours using available spoil to the maximum extent practicable. Pre-construction terrestrial and aquatic resources will be allowed to re-vegetate naturally upon project completion.

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MONITORING

Temporary impacts to emergent wetland areas north of Old Wallisville Road occur within or immediately adjacent to existing pipeline ROWs or clear-cut areas. Based on previous project experience, Buckeye anticipates that these areas will reestablish with comparable wetland vegetation.

Buckeye proposes post-construction vegetation surveys (monitoring) of the PEM fresh marsh wetland south of Old Wallisville Road (south of the proposed "push" site) to ensure successful restoration. For purposes of this project, successful restoration is defined as reestablishment of greater than 50% cover of hydrophytic vegetation in impacted wetland areas within two complete growing seasons following construction.

Monitoring will occur after the first complete growing season following construction. If the success criterion is not met after the first growing season following construction, a second monitoring survey will be conducted after the second growing season. Areas not meeting the success criteria after the second monitoring will be planted and/or seeded with comparable, commercially available wetland species. Monitoring will continue annually until the success criterion is met. Success of restoration measures will be documented in report form to the USACE within 30 days after completion of each monitoring survey.

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